

10/28/21

REVISED, TO REFLECT CURRENT COUNTY STANDARDS

REVISED SLAB DIMENSIONS

8. MANUAL AIR RELEASE ASSEMBLY TO INCLUDE 1" TAP W/ 1" x 2" 316 SS NIPPLE, 1" SS THREADED TEE, 1" x 1/2" SS REDUCING BUSHING, 1/2" SS BALL VALVE W/ 1/2" PVC THREADED PLUG, AND 1" SS BALL VALVE W/ 1" 9. COMPOUND PRESSURE GAUGE (STAINLESS STEEL, SILICONE FILLED, W/ SILICONE FILLED DIAPHRAGM SEAL), 10. ALUMINUM FRAME & DOUBLE ACCESS HATCH W/ 30"x 36" MIN. OPENING, HINGED ON DISCHARGE PIPING SIDE AND CAPABLE OF BEING SECURED IN THE OPEN POSITION. CONTRACTOR SHALL DRILL EIGHT 1/2" DIA. FOR PUMP STATIONS W/ 6' DIA. WET WELLS, AUX. SUCTION PIPE TO BE LOCATED BETWEEN THE DISCHARGE 21. EMERGENCY BYPASS/PUMP-IN 4" CAMLOCK MALE COUPLER W/ CAP, THREADED NIPPLE AND FLANGE 23. 3/4" DIA. SS ANCHOR BOLTS & NUTS (DOUBLE NUTS) PER PUMP MANUFACTURER'S RECOMMENDATIONS, 25. BASE ELBOW TO BE PROVIDED BY PUMP SUPPLIER (2 REQ). OUTLET TO HAVE THREADED NIPPLE AND 26. 2" FG 45° BEND (2 - AS REQUIRED FOR OFFSET IN WET WELL), LOCKING WASHER REQ'D FOR ALL FG 27. 2" 316L SS SCHEDULE 40 FLANGED DISCHARGE PIPING, LENGTH AS REQUIRED. LOCKING WASHER 31. 316 SS CONTROL CABLE HANGER FOR LEVEL TRANSDUCER AND FLOAT SWITCH CABLES - SEE DETAIL, 32. LEVEL FLOAT SWITCHES (3 MIN.), TO SERVE AS BACK-UP LEVEL SENSORS TO PRESSURE TRANSDUCER 33. PRESSURE TRANSDUCER FOR WATER LEVEL CONTROL, SUSPENDED FROM CONTROL CABLE HOOK. SET AT 37. NON-SHRINK GROUT FILLET ALL AROUND, 4000 PSI CONCRETE W/ MAX AGGREGATE SIZE OF 3/8" & MIN. SLOPE OF 1:1 (MAX WIDTH/HT. OF 2-FT), TO BE COATED W/ INTERIOR WET WELL PROTECTIVE COATING (SEE 38. FIRST WET WELL RISER SECTION & BASE SLAB SHALL BE MONOLITHICALLY OR INTEGRALLY CAST PER 43. ELECTRICAL CONDUITS (SCH 80 PVC, 2" MIN.), INSTALLED UNDER GRADE SLAB AND CENTERED IN WET WELL 49. 4" MJ PLUG VALVE w/ RJ - ISOLATION VALVE, TO BE LOCATED ON PUMP STATION PROPERTY AT RIGHT OF

* REFER TO ELECTRICAL DRAWINGS FOR STANDARD ELECTRICAL DETAILS, EQUIPMENT REQUIRED AND FOR COORDINATION OF MECHANICAL AND ELECTRICAL INSTALLATIONS GATES TO OPEN OUTWARD ----TYPICAL FALL PREVENTION ANCHORAGE POINT, TYPICAL FALL PREVENTION ANCHORAGE POINT, SECTION A TYPE, REFER TO FALL PREVENTION SECTION C TYPE, REFER TO FALL PREVENTION STRUCTURAL DRAWINGS FOR ADDITIONAL TYPE AND STRUCTURAL DRAWINGS FOR ADDITIONAL TYPE AND LOCATION OPTIONS. LOCATION OPTIONS. A 3' MINIMUM SEPARATION REQUIRED FROM CENTER TO ANY EXPANSION JOINT PEDESTAL FOOTPRINT SHALL NOT BE LOCATED (SAW CUT JOINTS OK). MINIMUM 5' SEPARATION WITHIN THE GATE OPENING. A 3' MINIMUM REQUIRED BETWEEN CENTERS OF ANCHOR POINTS. SEPARATION REQUIRED FROM CENTER TO ANY EXPANSION JOINT (SAW CUT JOINTS OK). - 6"x 6" GATE POST (TYP.) * ELECTRIC METER AND ALARM SILENCER * ALARM HORN & BEACON REFER TO STRUCTURAL DRAWING FOR - CONCRETE THICKNESS AND REINFORCING 10' (MIN) * CELLULAR ANTENNA * RTU/CONTROL PANEL * MAIN DISCONNECT 6' HIGH WOOD FENCE - SEE DETAIL, DRAWING M2 * AREA LIGHT ALL INTERIOR & EXTERIOR SURFACES OF — ABOVE-SLAB PIPING AND FITTINGS SHALL BE PROTECTED WITH CORROSION RESISTANT COATINGS MINIMUM SLAB DIMENSIONS WIDTH X DEPTH 6' INSIDE DIA. WETWELL ... 28' X 26'-6" STANDARD FOOTPRINT - MIN. DIMENSIONS SCALE: 1" = 4'-0"

SHOW TO SCALE AND INCLUDE ELEVATIONS AS TO ROAD. SLAB. DRIVEWAY AND SURROUNDING AREAS.

> DETAILED SITE PLAN (BY ENGINEER)



PUMP AND PIPE SPACING IS ACCOMMODATED.

CONNECTION DETAIL, DRAWINGS S2, S4 & M3).

PUMP STATION SLAB DIMENSIONS SHALL MEET OR EXCEED MINIMUM SHOWN.

RESPONSIBLE FOR THE FINAL ELECTRICAL, MECHANICAL, AND STRUCTURAL DESIGNS.

[INSTALLED HEIGHT (PER PUMP MFR.) + 3" = ___FT] ≤ [LWL - BOTTOM EL. = ___FT]

DISCHARGE PIPE SUPPORTS ARE REQUIRED FOR WET WELL DEPTHS GREATER THAN 10 FEET.

1. 2" FG 90° SS BEND (2 REQ.)

PROVIDE ONE PER STATION.

HOLES IN HATCH COVER.

EPOXIED INTO BASE SLAB

CONNECTIONS IN WET WELL

18 INCHES ABOVE BOTTOM

REQ'D FOR ALL FG CONNECTIONS IN WET WELL

ASTM C478 - REFER TO STRUCTURAL DRAWING S1-S4

PUMP STATION DESIGN NOTES (TYP):

TOP SLAB, FOUR TOTAL - SEE ELECTRICAL DETAILS AND STRUCTURAL DRAWING S1-S4

IN ORDER TO COORDINATE THE MECHANICAL, ELECTRICAL AND STRUCTURAL INSTALLATION, THE DESIGN ENGINEER SHALL REFER TO HILLSBOROUGH COUNTY'S MECHANICAL DRAWINGS (M1-M3), ELECTRICAL DRAWINGS (E 0.0-E 5.0), STRUCTURAL DRAWINGS (S1-S4); AND THE "HC WATER, WASTEWATER & RECLAIMED

WATER, WASTEWATER & RECLAIMED WATER TECHNICAL SPECIFICATIONS" (LATEST EDITION).

WATER TECHNICAL MANUAL FOR SUBDIVISION AND SITE DEVELOPMENT" (LATEST EDITION), AND THE "HC

THE DESIGN ENGINEER SHALL NOT USE THESE DRAWINGS FOR A SPECIFIC SITE INSTALLATION. A DETAILED

DRIVEWAY, AND SURROUNDING AREAS - INCLUDING FINISHED FLOOR OF BUILDINGS ON ADJACENT LOTS),

THESE DRAWINGS REPRESENT THE STANDARD DESIGN FOR ALL HILLSBOROUGH COUNTY WASTEWATER

PUMPING STATIONS. IT WAS DEVELOPED TO IMPROVE RELIABILITY AND MAINTAINABILITY, MINIMIZE SPARE

SITE PLAN SHALL BE SHOWN IN THE BOX PROVIDED ON THIS SHEET, OR ON A SEPARATE SHEET AS NEEDED.

THE SITE PLAN SHALL BE DRAWN TO SCALE AND INCLUDE CRITICAL SITE ELEVATIONS (SUCH AS ROAD, SLAB,

DIMENSIONS, HARDSCAPE ELEMENTS, AND THE PUMP STATION'S RELATIONSHIP TO THE SURROUNDING AREA.

PARTS AND INCREASE SERVICE LIFE. ALL REQUESTS FOR DEVIATIONS FROM THIS STANDARD MUST BE MADE IN

WRITING TO THE DEVELOPMENT SERVICES DEPARTMENT FOR SUBDIVISION AND SITE DEVELOPMENT; AND TO

THE ENGINEER IS ADVISED THAT COUNTY APPROVAL OF THE PUMP STATION DESIGN DOES NOT CONSTITUTE A

RELEASE FROM PROFESSIONAL LIABILITY BY THE ENGINEER NOR SHIFT RESPONSIBILITY FOR ANY DESIGN

IF THE INFLUENT INVERT ELEVATION IS GREATER THAN 2-FEET ABOVE THE LOW WATER LEVEL (LWL), A DROP

LOW WATER LEVEL MUST BE AT LEAST 3" ABOVE TOP OF PUMP. FILL IN THE FOLLOWING INFORMATION:

INVERT CONNECTION SHALL BE REQUIRED, DROP INVERT TO BE SET AT THE LEAD-ON ELEVATION (SEE DROP

DECISIONS REPRESENTED HEREIN TO THE COUNTY OR OTHER REGULATORY AGENCY. THE ENGINEER IS

THE PUBLIC UTILITIES DEPARTMENT (PUD) PROJECT MANAGER FOR ALL CAPITAL IMPROVEMENT PROJECTS.

WRITTEN APPROVAL FROM PUD UTILITY DESIGN SECTION MGR. IS REQUIRED BEFORE MODIFICATIONS ARE

THE ENGINEER IS RESPONSIBLE FOR COORDINATING WITH THE PUMP SUPPLIER TO ENSURE THAT PROPER


PVC UNDER-SLAB DRAIN - SEE DETAIL, DRAWING M3

STANDARD WASTEWATER GRINDER PUMP STATION


MECHANICAL LAYOUT AND SITE PLAN

FILE NUMBER ISSUE DATE: OCTOBER 2023 SCALE HORIZONTAL: DRAWING NUMBER DRAWN DESIGNED VERTICAL: CHECKED PROJ. MGR.


STATUS: FINAL DESIGN

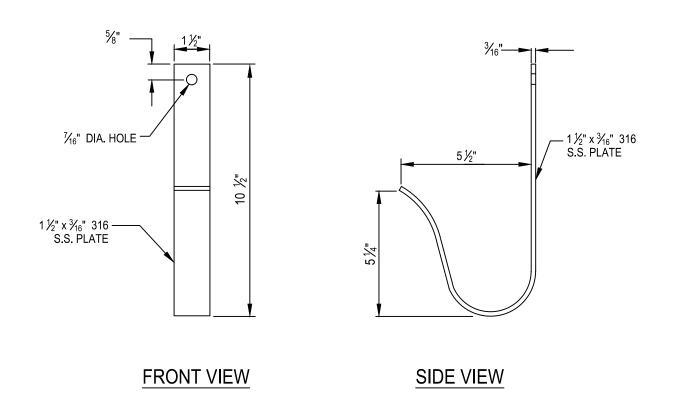


POWER & TRANSDUCER CABLE HOOK DETAIL NOT TO SCALE

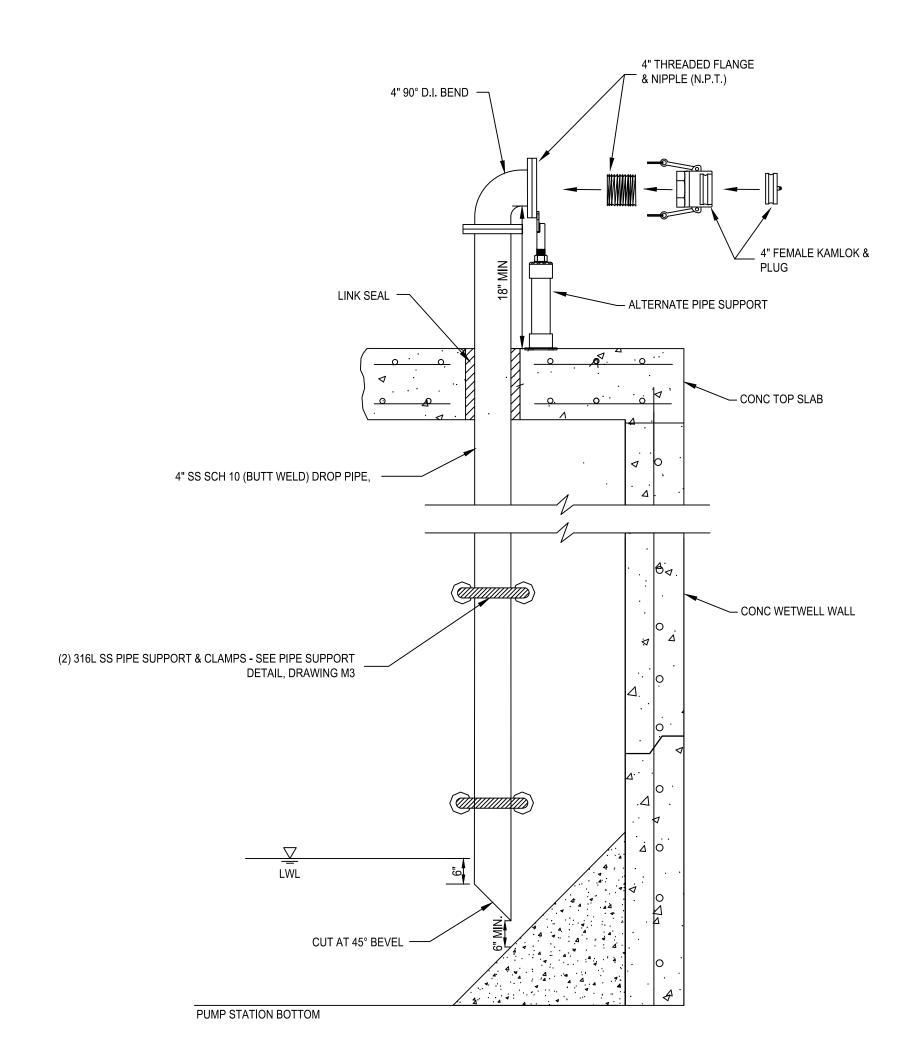



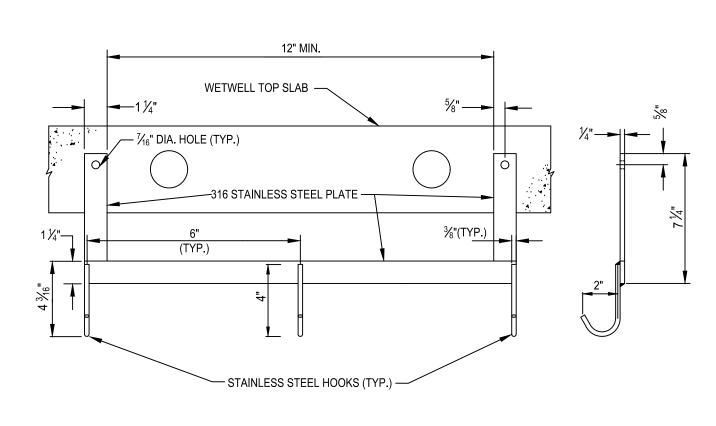


LEVEL CABLE HANGER DETAIL NOT TO SCALE

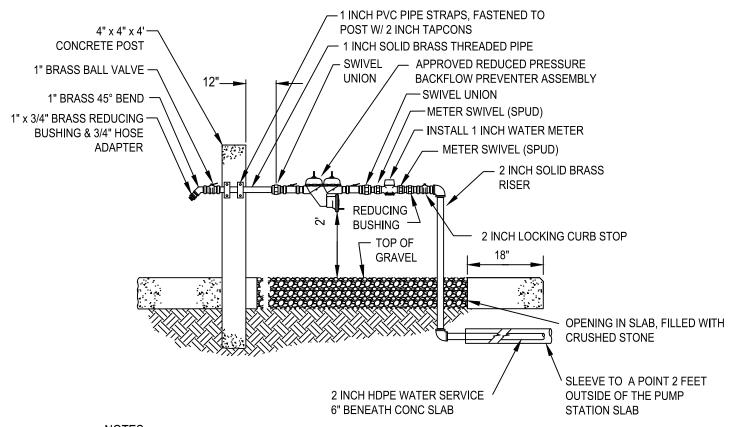


NOTES:

- 1. ALL PIPING TO BE 2-INCHES UP THROUGH THE LOCKING CURB STOP.
- 2. 2 INCH SERVICE LINE SHALL USE A 2 INCH TAPPING SLEEVE & VALVE AT THE WATER MAIN CONNECTION.
- 3. FOR LARGE PUMP STATIONS (WET WELLS 10 FT. DIA. OR GREATER, OR 20 FT. OR MORE DEPTH), A 2 INCH WATER METER AND SERVICE SHALL BE PROVIDED. HOSE CONNECTION TO BE 2 INCH MALE CAMLOCK CONNECTOR.

WATER SERVICE DETAIL NOT TO SCALE

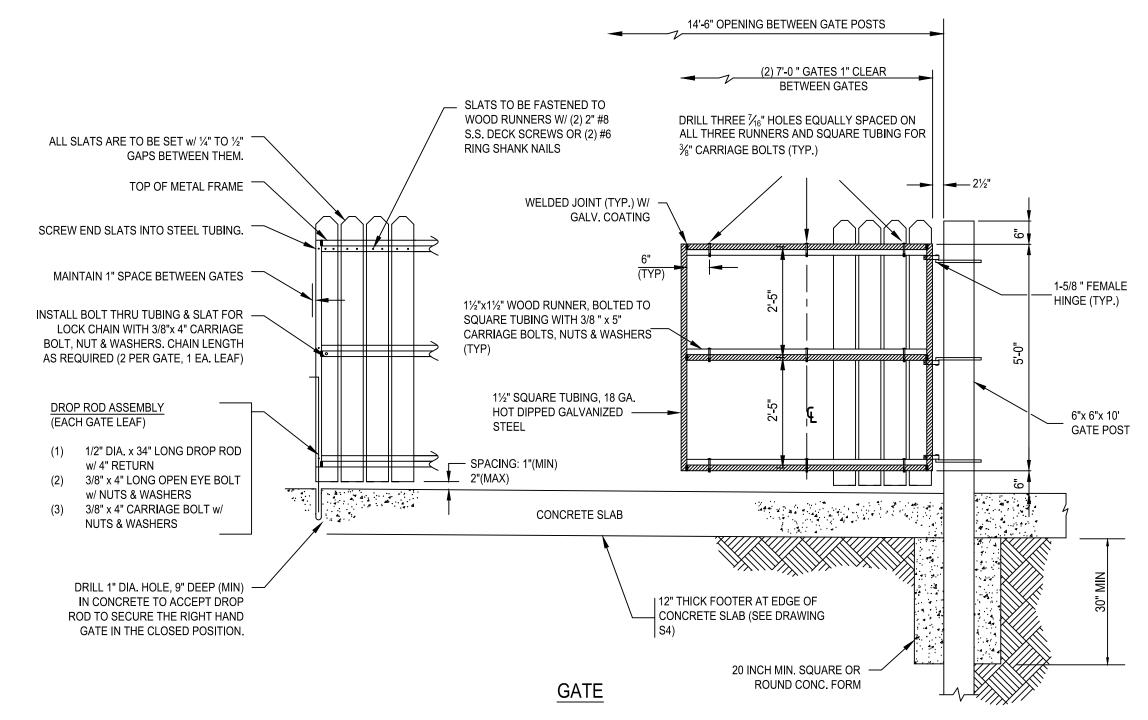

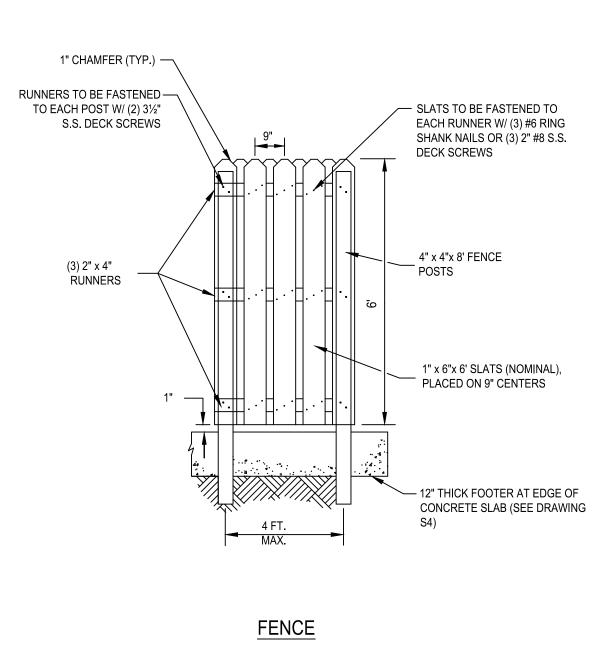

FENCE & GATE CONSTRUCTION NOTES


- ALL WOOD SHALL BE PRESSURE TREATED. POSTS SHALL BE RATED FOR BURIED WOOD.
- ALL STRUCTURAL MEMBERS AND CROSS BRACING AS SHOWN. CROSS BRACING SHALL BE ON INSIDE OF GATE.
- USE HOT DIP GALVANIZED OR STAINLESS STEEL HARDWARE, FASTENERS, DROP RODS, CABLES, ETC. FOR ALL FENCE AND
- GATE CONSTRUCTION.
- 5. ALL NAIL & SCREW HEADS SHALL BE SET FLUSH W/ WOOD SURFACE (NOT COUNTER-SUNK).
- USE TAMPER PROOF HEAVY DUTY HINGES AND LATCHES ON GATE (MINIMUM OF THREE HINGES PER GATE LEAF).
- SOME PUMP STATION LOCATIONS MAY REQUIRE ARCHITECTURAL STYLE FENCING - CONSULT COUNTY.

PUMP STATION ENCLOSURE DETAIL

NOT TO SCALE

INSTALLATION NOTE: CONTRACTOR TO REFER TO DRAWINGS M1-M3, E 0.0-E 5.0 AND S1-S4 IN ORDER TO COORDINATE ALL MECHANICAL, ELECTRICAL AND STRUCTURAL

INSTALLATIONS.

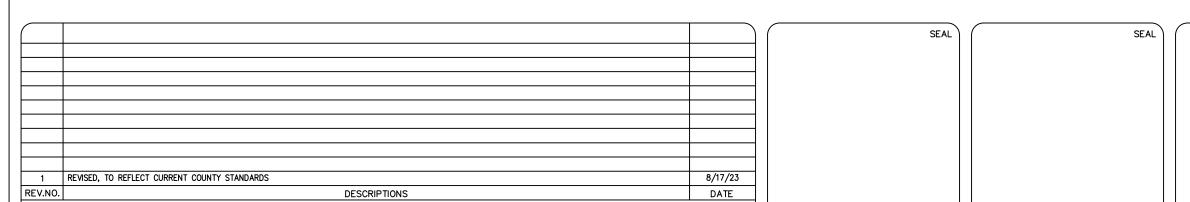




PUBLIC UTILITIES DEPARTMENT TECHNICAL SERVICES DIVISION 925 E. TWGGS STREET/TAMPA FLORIDA 33602/PH. (813) 272-5977


STANDARD WASTEWATER GRINDER PUMP STATION

MECHANICAL DETAILS


ISSUE DATE: OCTOBER 2023	SCALE	FILE NUMBER
PROJ. # DRAWN	HORIZONTAL:	DRAWING NUME
DESIGNED CHECKED	VERTICAL:	M2
PROJ. MGR.	NA	
(STATUS:		

FINAL DESIGN

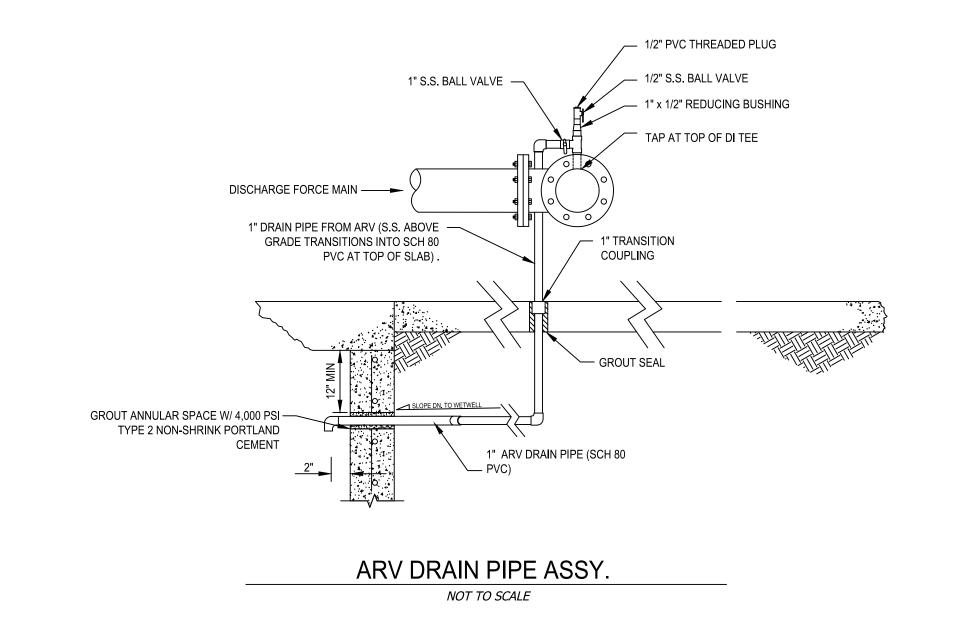

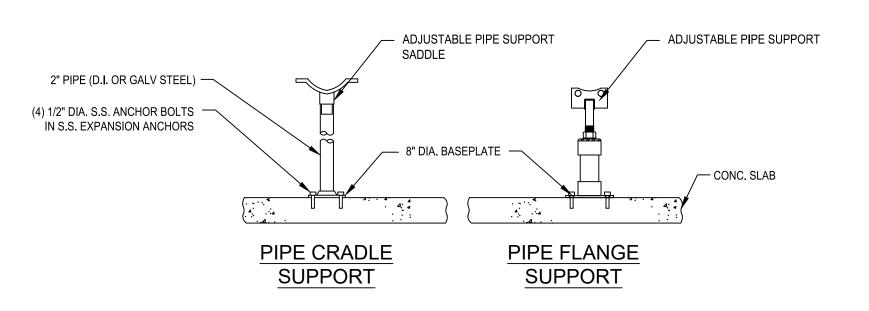

EXTERIOR PIPE SUPPORT DETAIL NOT TO SCALE

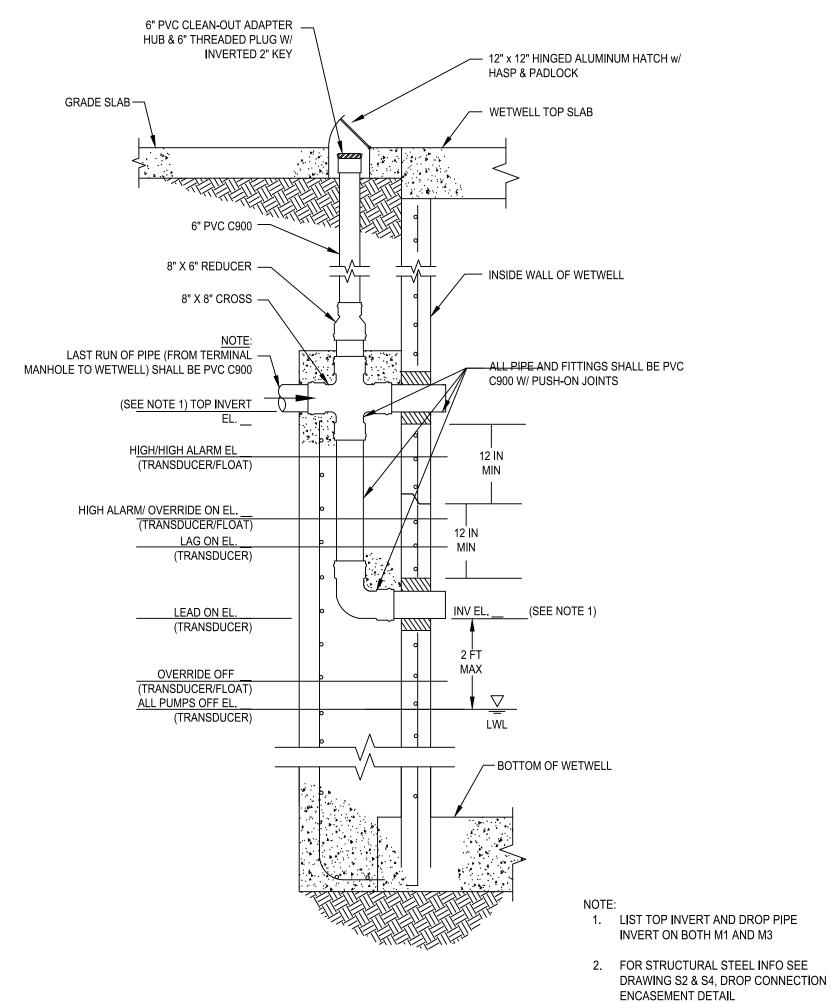



INTERIOR PIPE & GUIDE RAIL SUPPORTS - TOP VIEW NOT TO SCALE

4" AUXILIARY SUCTION

PUMP DISCHARGE PIPE — PROVIDE ADDITIONAL PIPE SUPPORT EVERY 10 FEET


2" DIA. S.S. TUBING, ANGLE IRON, OR PIPE WELDED TO S.S. BASE PLATES, BOLT TO WET WELL WITH 5/8" S.S. EXPANSION ANCHORS

GUIDE RAIL SUPPORT BRACKET.

MOUNTS ON PUMP DISCHARGE PIPE
W/ 1/2" SS U-BOLTS AND LOCKNUTS.
CONTRACTOR TO FABRICATE
EXTENSION BRACKET WHEN
REQUIRED.

DROP CONNECTION DETAIL NOT TO SCALE

INSTALLATION NOTE: CONTRACTOR TO REFER TO DRAWINGS M1, M2, M3, E 0.0-E 5.0, AND S1-S4 IN ORDER TO COORDINATE ALL MECHANICAL, ELECTRICAL AND STRUCTURAL INSTALLATIONS.

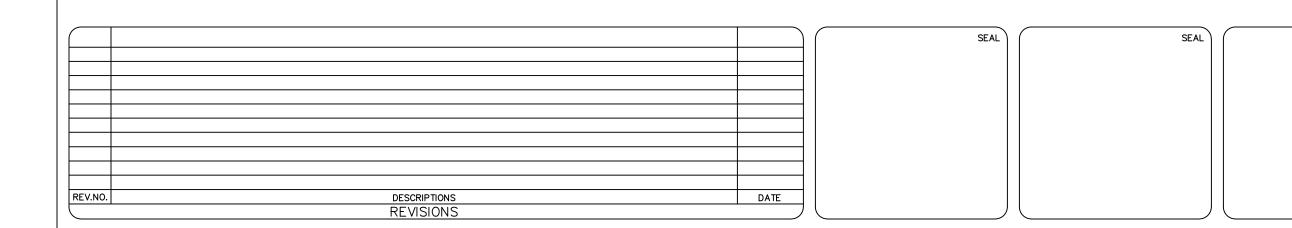



PUBLIC UTILITIES DEPARTMENT TECHNICAL SERVICES DIVISION 925 E. TWIGGS STREET/TAMPA FLORIDA 33602/PH. (813) 272-5977

— CONCRETE WETWELL

_ 3/4" S.S. U-BOLTS w/S.S.

LOCK NUTS

STANDARD WASTEWATER GRINDER PUMP STATION

MECHANICAL DETAILS

SUE DATE: OCTOBER 2023	SCALE	FILE NUMBER
OJ. #		
AWN	HORIZONTAL:	DRAWING NUMBER
SIGNED		
ECKED	VERTICAL:	M3
OJ. MGR.	NA J	

STATUS: FINAL DESIGN